RESOLUTION No. 16-224

A RESOLUTION OF THE MAYOR AND THE CITY COUNCIL OF THE CITY OF DORAL, FLORIDA, APPROVING THE SITE PLAN FOR DE LEO CENTER, LOCATED AT 8470 NW 58 STREET DORAL, FLORIDA; PROVIDING FOR IMPLEMENTATION; AND PROVIDING FOR AN EFFECTIVE DATE

WHEREAS, On November 18, 2015, the City of Doral adopted Ordinance No. 2015-40 amending the City's Land Development Code to establish procedures for the Mayor and City Council site plan review and approval process; and

WHEREAS, DM De Leo Motors CA, LLC (the "Applicant") has submitted an application for Mayor and Council site plan review and approval for multi-tenant facility which includes office, showroom and warehouse space located at 8470 NW 58 Street, as legally described Exhibit "A", which is incorporated herein and made a part hereof by this reference; and

WHEREAS, staff recommend approval of the proposed site plan provided in Exhibit "B" (the "Site Plan"), which is incorporated herein and made a part hereof by this reference; and

WHEREAS, pursuant to law, notice has been given by publication in a paper of general circulation in the City, notifying the public of this proposed Resolution and of the public hearings; and

WHEREAS, the Mayor and City Council find that the adoption and implementation of this Resolution is in the best interest and welfare of the residents of the City.

NOW, THEREFORE, BE IT RESOLVED BY THE MAYOR AND CITY COUNCIL OF THE CITY OF DORAL, FLORIDA, THAT:

Section 1. Recital. The above recitals are true and correct and incorporated herein.

<u>Section 2.</u> <u>Approval of Site Plan.</u> The Site Plan, providing for the development of 2,250 sq. ft. of office area, 3,255 sq. ft. of showroom area, and 9,335 sq. ft. of warehouse space, for a total building area of 14,840 sq. ft. is hereby approved, subject to the following conditions, which are agreed to by the Applicant and City, as part of the site plan development agreement approval.

- 1. Applicant must submit separate plans for Entrance Feature.
- 2. All applicable impact fees shall be paid by the Applicant prior to issuance of a building permit.
- The proposed project shall be built in substantial conformance with the plans entitled De Leon Center, prepared by Cabrera Ramos Architects, Inc., dated stamped received September 28, 2016, consisting of 6 sheets, as amended.
- 4. The Property shall be landscaped in accordance with the landscape plan, prepared by Cabrera Ramos Architects, Inc., date received September 28, 2016, as amended, and included with the site plan submittal.
- 5. Issuance of this development permit by the City of Doral does not in any way create any right on the part of an Applicant to obtain a permit from a state or federal agency and does not create any liability on the part of the City of Doral for issuance of the permit if the applicant fails to obtain requisite approvals or fulfill the obligations imposed by a state or federal agency or undertakes actions that result in a violation of state or federal law.
- 6. Approval from Division of Environmental Resources Management (DERM) is required at time of building permit. If DERMs' requirements result in a modification to the approved administrative site plan, which may include but is not limited to, the layout of proposed parking field, the Applicant will be fully responsible to meet those requirements prior to building permit approval.
- 7. Approval from Miami Dade County Fire Department is required at time of building permit.
- 8. The applicant shall comply with Ordinance No. 2015-09 "Public Arts Program".

- 9. All applicable local, state and federal permits must be obtained before commencement of the development.
- 10. The project shall comply with the requirements set forth in Ordinance No. 2016-03, if applicable.
- 11. The project should make every effort to incorporate the Low Impact Development (LID) practices in the project design consistent with Section 74-881 of the Land Development Code.
- 12. Provide compliance with the Floodplain Management regulation (Sec. 53-344) of the City's Land Development Code. Project team should contact the City's Floodplain Administrator to review the requirements of the Floodplain Management Ordinance.
- 13. Applicant shall indicate how the project will meet the requirement of the LDC Sec. 77-195 of the City's Land Development Code solar reflective index (SRI) of 28 or greater.
- 14. Project shall meet the City's Green Ordinance requirements in Chapter 63 of the Land Development Code.
- 15. The Applicant shall comply with applicable conditions and requirements provided by Miami-Dade County Public Works Department, Water and Sewer Department, Fire Rescue Department, and Regulatory and Economics Resources (DRER) prior to issuance of building permit.
- 16. The hours of operation during the construction shall adhere to as per Noise Ordinance No. 2011-01.
- 17. The Applicant shall submit a construction staging plan for review and approval prior to commencement of construction. The staging area shall be kept clean at all times, adequately screened and located away from view of existing homes located adjacent to the construction site.
- 18. Access points for construction vehicles shall be identified as part of the construction plan submitted to the City. Construction vehicles with access to the site shall adhere to existing "no thru truck" areas.
- 19. The Applicant shall provide a Construction Air Quality Management Plan to the Department prior to the start of construction.
- 20. A Stormwater Pollution Prevention Plan (SPPP) must be submitted by the Applicant at time of building permit. The Plan should provide guidelines for implementing an erosion and sedimentation control program before the site is cleared or graded, including areas where top soil will be removed and contours of slopes will be cleared. The Plan shall also include location and type of erosion control measures, storm water and sediment management systems, and a vegetative plan for temporary and permanent stabilization. The Plan shall remain on-site for the duration of the construction activity.
- 21. The Applicant shall preserve existing trees (including native trees) during the development of the project, wherever possible. If the trees must be removed, the Applicant shall be required to mitigate the impact in accordance with DRER requirements. If the relocated trees do not survive, the Applicant shall be required to replace the trees in compliance with DRER requirements.

- 22. The Applicant shall meet the requirements of the Miami-Dade County Water-Use Efficiency Standards Manual, effective January 2009, as may be amended from time to time.
- 23. All stormwater shall be retained on site in accordance with applicable law.
- 24. All stormwater drainage systems shall be maintained in working conditions at all times in order to avoid localize flooding during and after a storm.
- 25. Parking shall be prohibited on top of any drainage inlet or drainage manhole.
- 26. Developer shall be responsible for providing the City a certified drainage inspection report prior to the issuance of a certificate of occupancy.
- 27. If more than one (1) acre of land is disturbed during construction the Contractor/Developer is responsible to obtain NPDES Stormwater permit coverage through the Florida Department of Environmental Protection (FDEP) Construction Generic Permit (CGP). If the project is less than one (1) acre, but part of a larger common plan of development or sale that will ultimately disturb one or more acres, permit coverage is also required. Instruction to request and obtain a CGP can be found at: http://www.dep.state.fl.us/water/stormwater/npdes/docs/cgp.pdf. Contractor/Developer should submit the Notice of Intent (NOI) with the appropriate processing fees to the NPDES Stormwater Notices Center. Contractor/Developer must apply for permit coverage at least two (2) days before construction begins.
- 28. Provide tree removal/relocation approval from (DERM), including an approved tree disposition plan at time of building permit.
- 29. Noncompliance with the approved site plan and the terms of this approval shall be considered a violation of the City Code. This approval will be subject to cancellation.
- 30. The project shall comply with the requirements set forth in Section 74-152 of the City's Land Development Code.
- 31. As per Section 74-152 of the City's Land Development Code, dealerships and/or wholesale for cars are not permitted on site(s) less than two (2) acres. And therefore, if that happens here, the City has the right to deny this approval.
- 32. The applicant shall adhere to the recommendations as depicted on the DERM approval letter (dated: Jun. 15, 2016, MDC# MZ2016000017).
- 33. NW 58 Street is a Miami-Dade County R/W. R/W improvements or modifications may be required in the Paving and Drainage process.

Res. No. 16-224 Page 5 of 5

<u>Section 3.</u> <u>Implementation.</u> The City Manager and the City Attorney are hereby authorized to take such further action as may be necessary to implement the purpose and provisions of this Resolution.

<u>Section 4.</u> <u>Effective Date.</u> This Resolution shall become effective upon its passage and adoption by the City Council and is binding on all successors and assigns.

The foregoing Resolution was offered by Councilmember Cabrera who moved its adoption. The motion was seconded by Councilmember Rodriguez and upon being put to a vote, the vote was as follows:

Mayor Luigi Boria	Yes
Vice Mayor Christi Fraga	Yes
Councilman Pete Cabrera	Yes
Councilwoman Ana Maria Rodriguez	Yes
Councilwoman Sandra Ruiz	No

PASSED AND ADOPTED this 26 day of October, 2016.

UIGI BORIA, MAYOR

ATTEST:

CONNIE DIAZ, CMC

CITY CLERK

APPROVED AS TO FORM AND LEGAL SUFFIENCY FOR THE USE AND RELIANCE OF THE CITY OF DORAL ONLY:

WEISS, SEROTA, HELFMAN, COLE & BIERMAN, P.L.

CITY ATTORNEY

EXHIBITS

Tract "A" of "HALL TRACT", according to the plat thereof as recorded in Plat Book 82, at Page 26, of the Public Records of Miami-Dade County. Florida

De Leo Center


8470 N.W. 58 th St, Doral, FL. 33166




Index of Drawings


A-O COVER SHEET
A-I.O OVERALL SITE PLAN
A-2.O FLOOR PLAN
A-3.O EXTERIOR ELEVATIONS
L-I.O LANDSCAPE PLANTING PLAN

Architect:

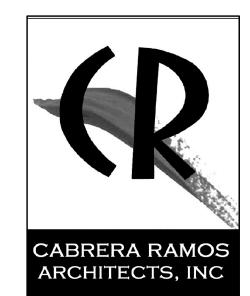



9851 N.W. 58 ST. # 107, Doral, Florida 33178 tel: (305) 593-0750 fax: (305) 593-8862 AA C001621

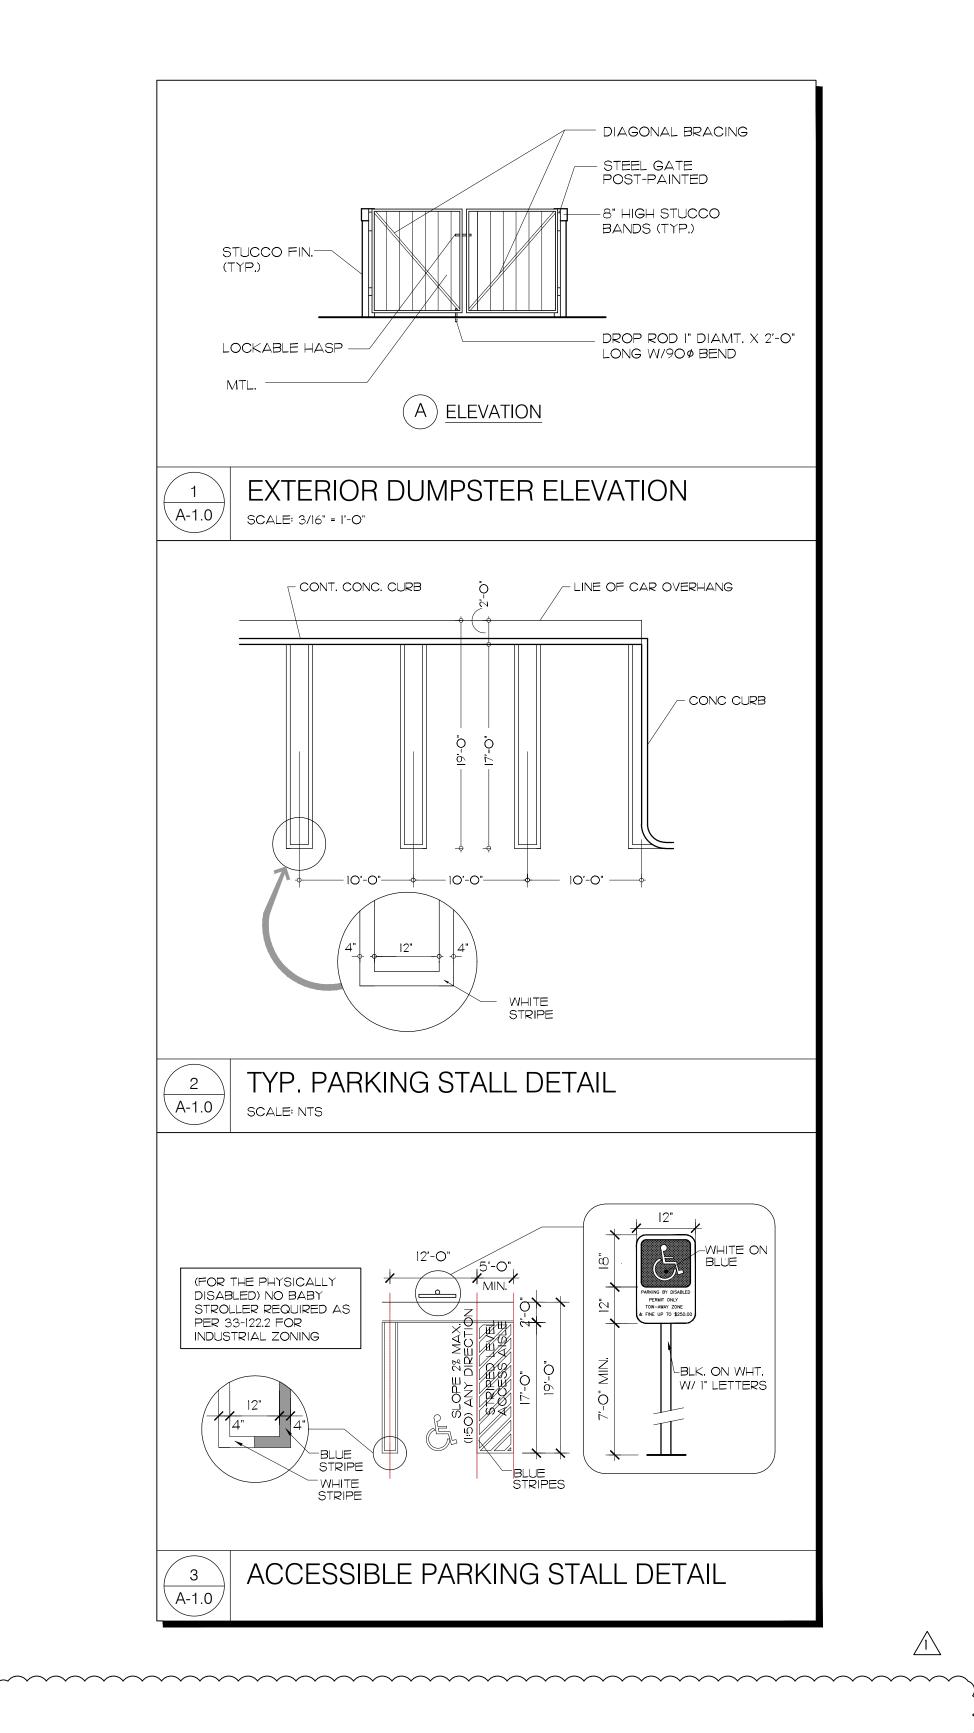


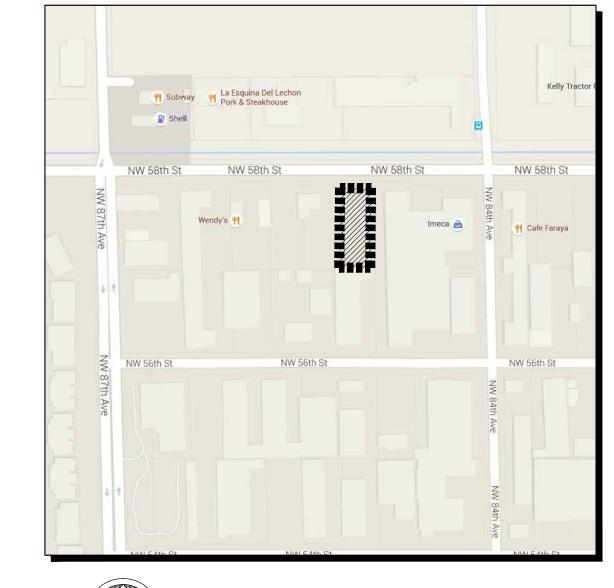




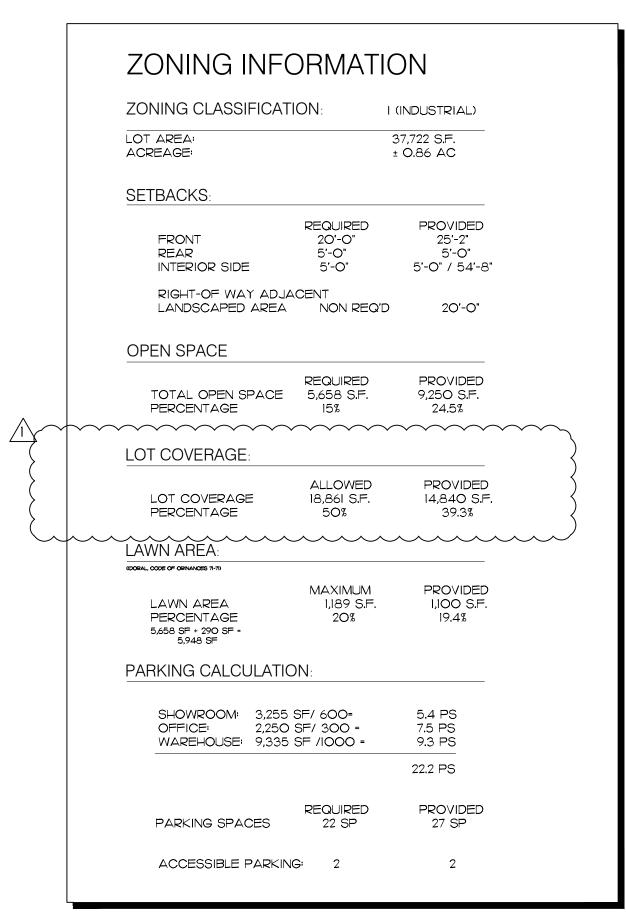

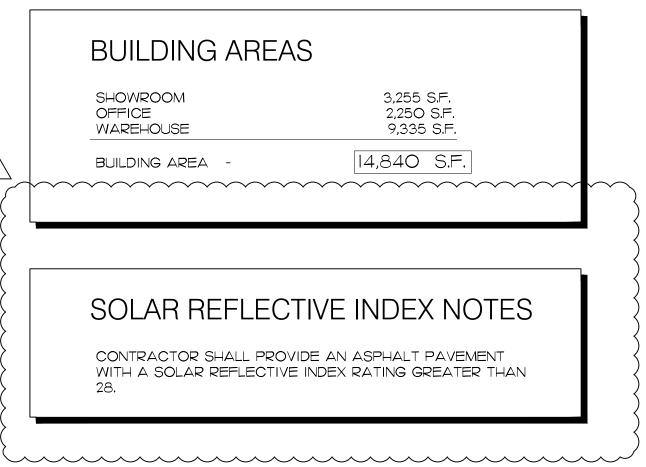

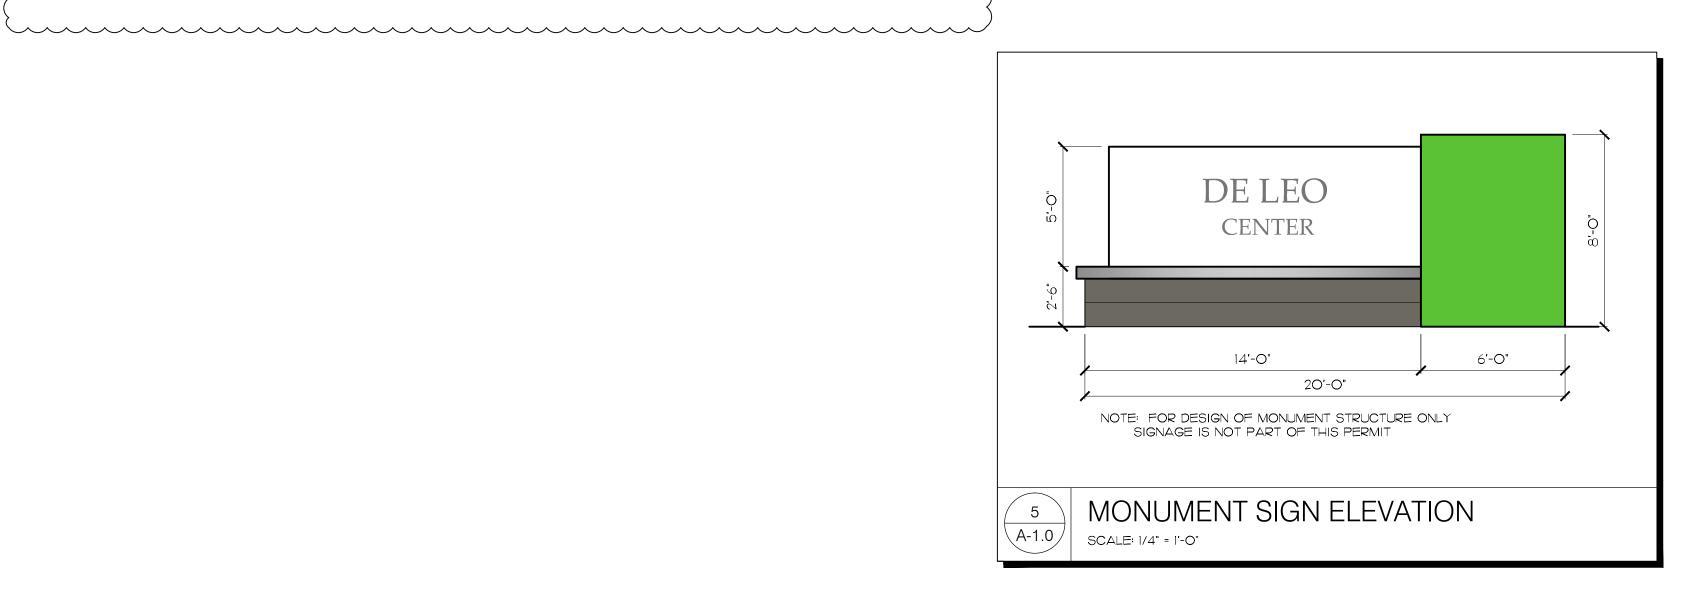

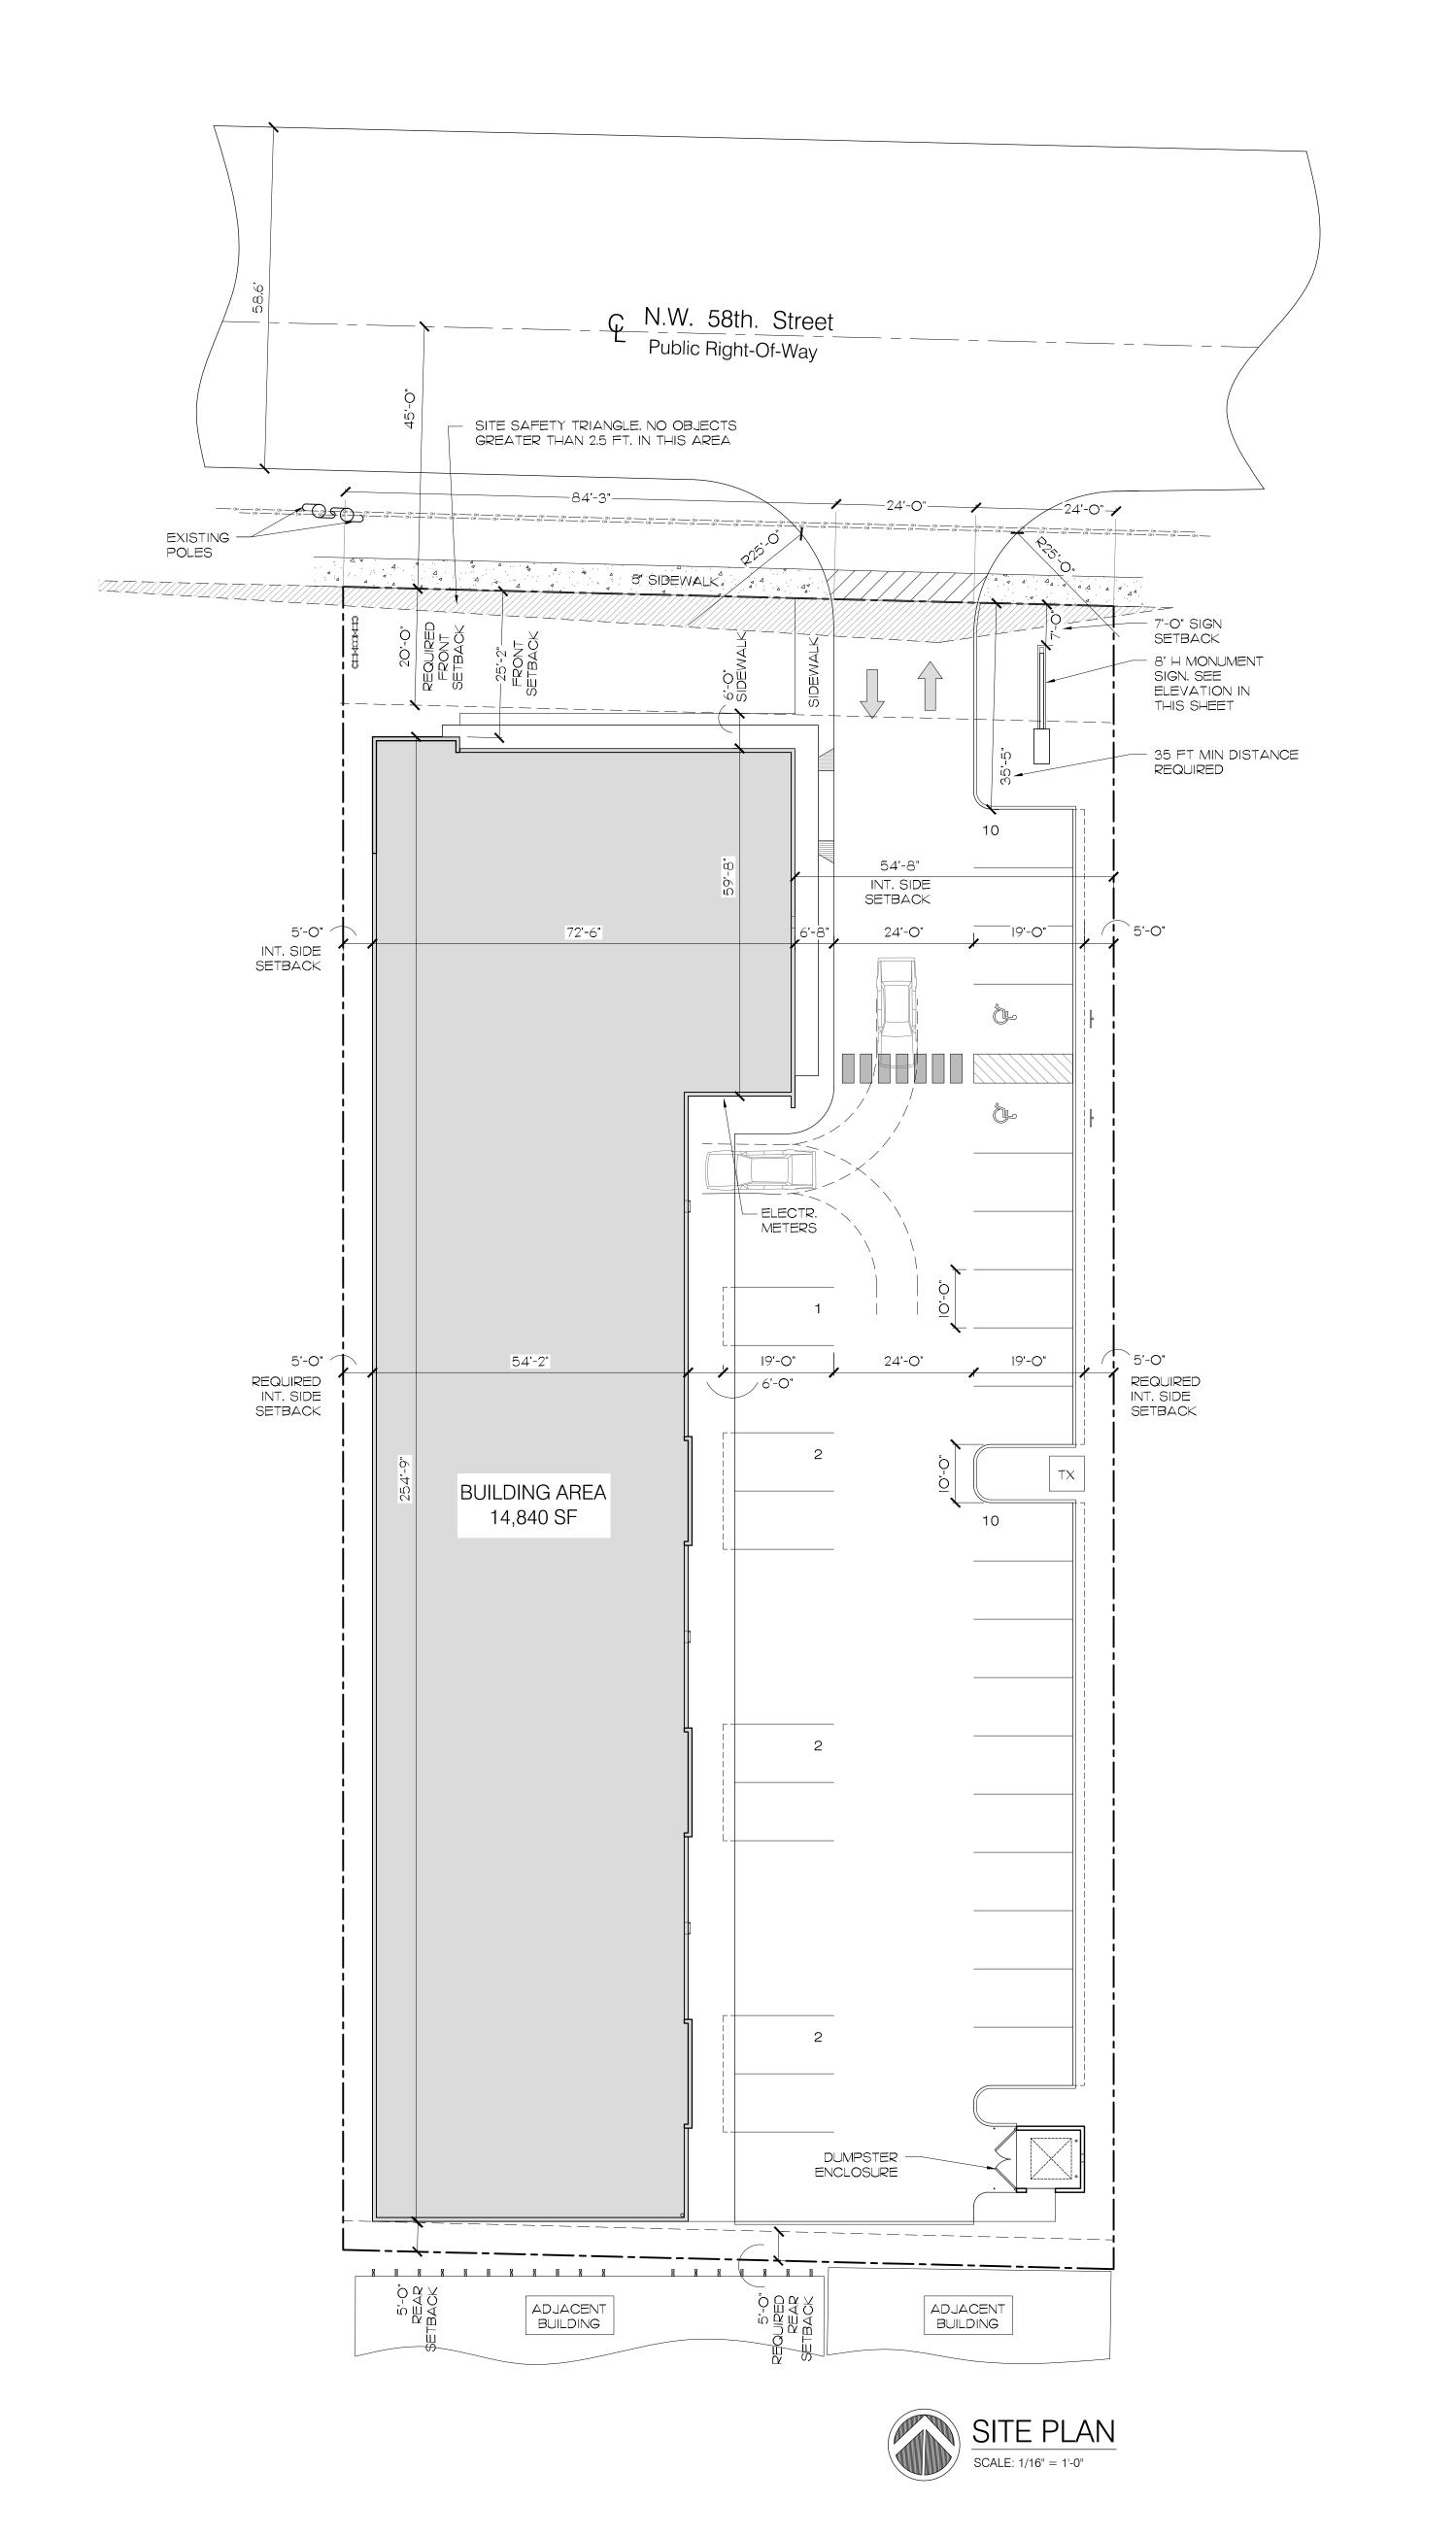

REVISIONS: 8-15-16
ASPR COMMENTS

CABRERA RAMOS ARCHITECTS, INC.

9851 NW 58 STREET. #107 DORAL, FLORIDA 33178 T:305.593.0750 F:305.593.8862 AA C001621

MIGUEL A. CABRERA JR., R.A. State Reg. No. AR13118

ROSA E. RAMOS-BOTTA, R.A. State Reg. No. AR15209 © 2016 CABRERA RAMOS ARCHITECTS, INC.


The Design and Drawings for this Project

are the property of the Architect and are protected under the Copyright Protection Act.

JOB NO.: 2077-16 SEAL

SHEET NO.

A-1.0

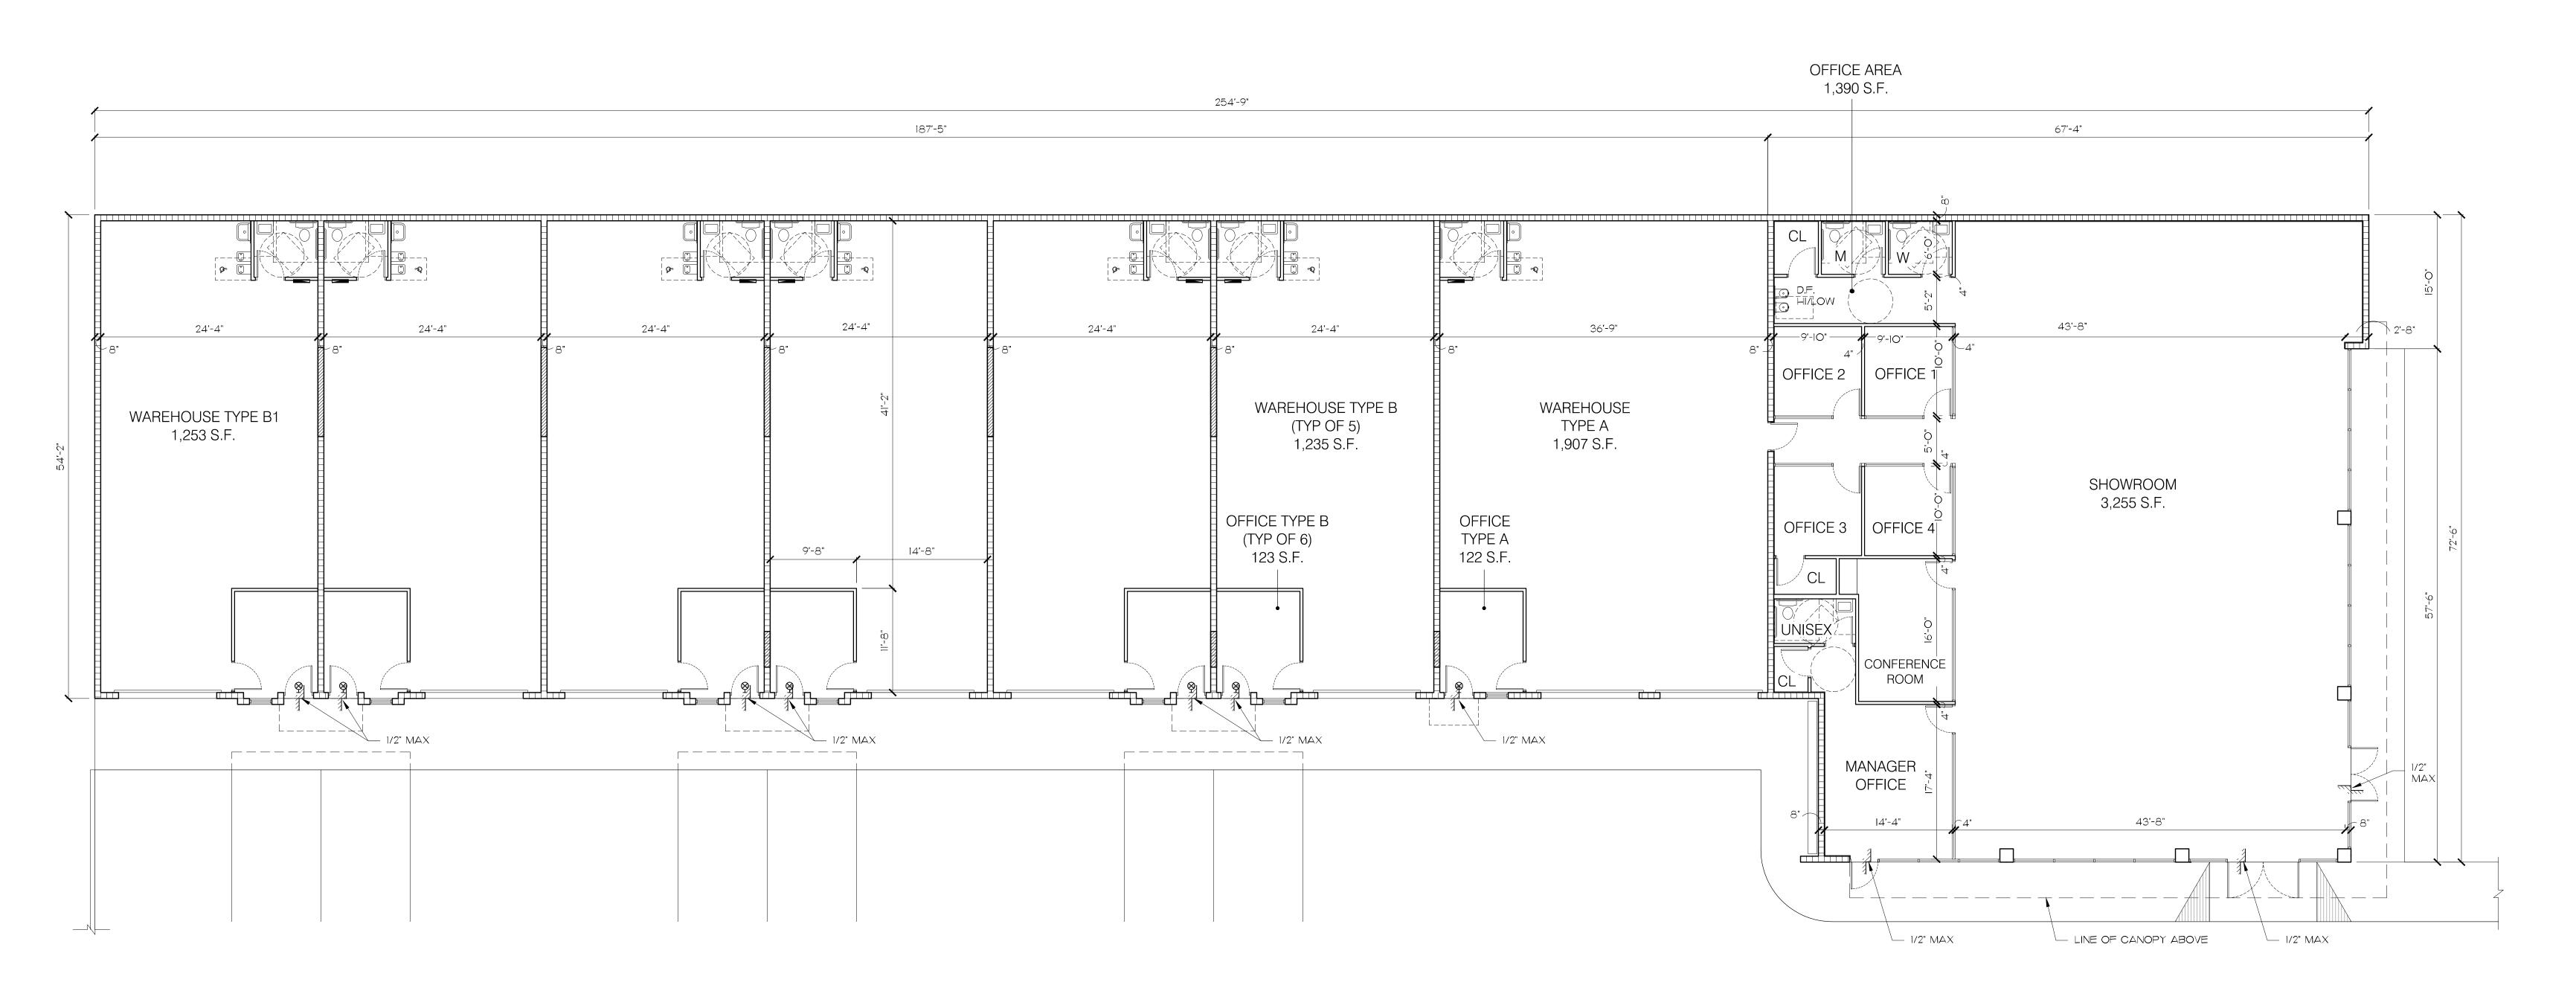



. REVISIONS:

4 LLC , Doral, FL 33166

DM De Leo Motors CA 8470 NW 58 th Street, I

CABRERA RAMOS ARCHITECTS, INC.

9851 NW 58 STREET. #107 DORAL, FLORIDA 33178 T:305.593.0750 F:305.593.8862 AA C001621

MIGUEL A. CABRERA JR., R.A. State Reg. No. AR13118 ROSA E. RAMOS-BOTTA, R.A.

State Reg. No. AR15209

© 2016 CABRERA RAMOS ARCHITECTS, INC.
The Design and Drawings for this Project are the property of the Architect and are protected under the Copyright Protection Act.

DATE: 04-11-2016

DRAWN: DRC


CHECKED BY: MAC


JOB NO.: 2077-16

SEAL

SHEET NO.


A-2.0

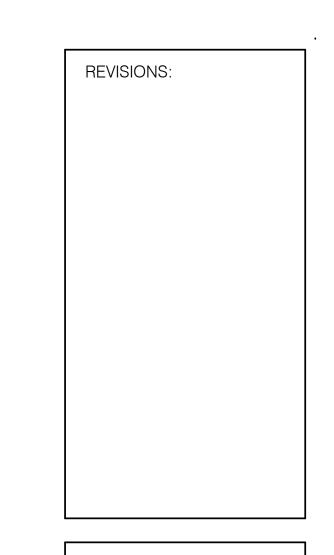

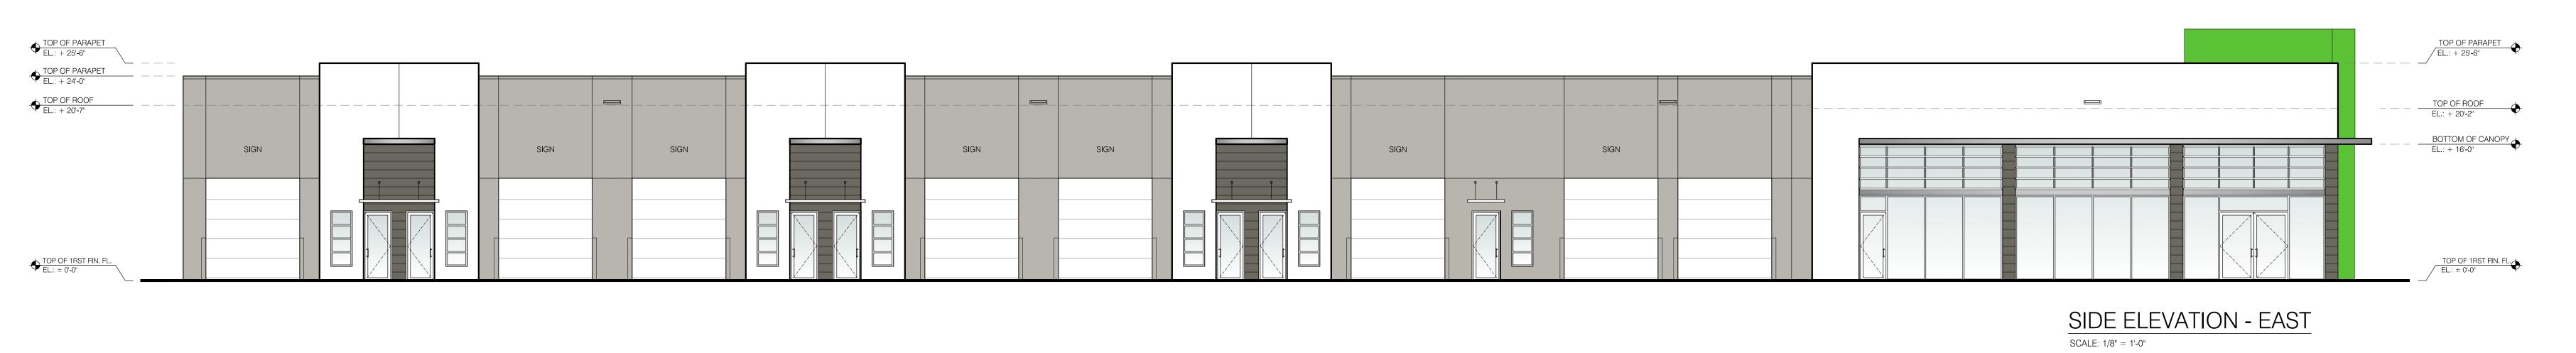

BEAR ELEVATION - SOUTH

SOUTH 10-19-

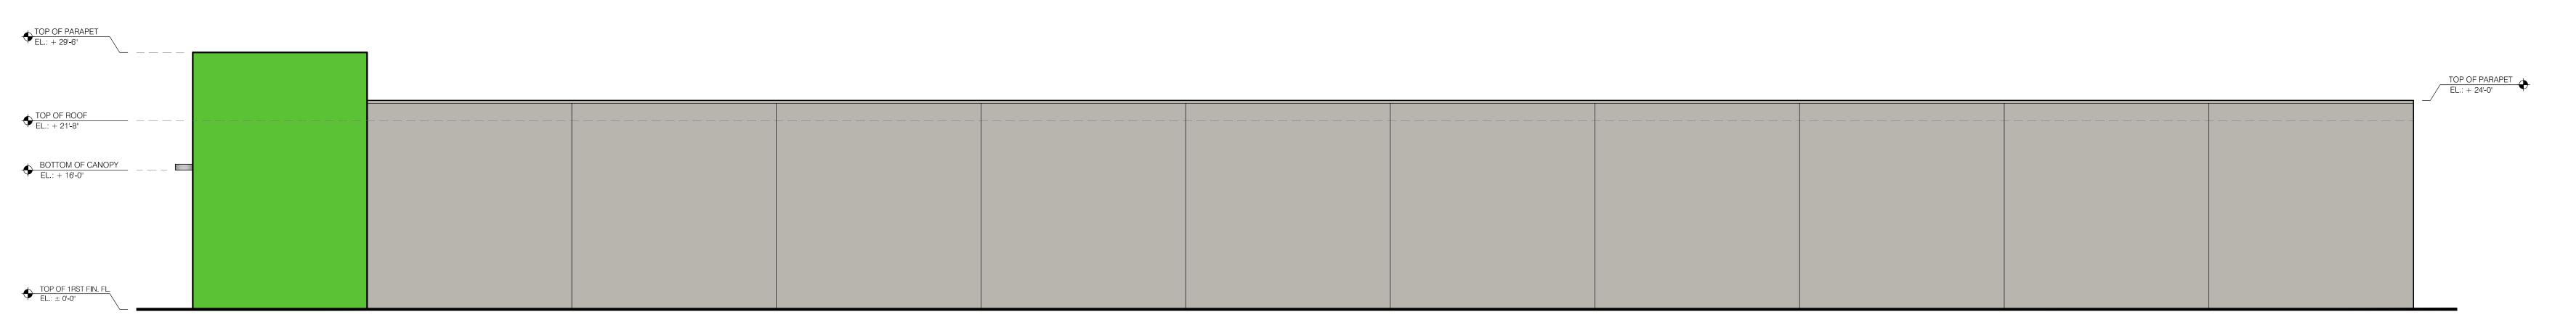


SIDE ELEVATION - WEST

SCALE: 1/8" = 1'-0"

De Leo Center

Owner:

BM De Leo Motors (
8470 NW 58 th Stree

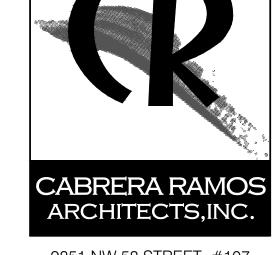

9851 NW 58 STREET. #107 DORAL, FLORIDA 33178 T:305.593.0750 F:305.593.8862 AA C001621

MIGUEL A. CABRERA JR., R.A.
State Reg. No. AR13118

ROSA E. RAMOS-BOTTA, R.A.
State Reg. No. AR15209

© 2016 CABRERA RAMOS ARCHITECTS, INC.
The Design and Drawings for this Project
are the property of the Architect and are
protected under the Copyright Protection Act.

DATE: 04-11-2016

DRAWN: DRC

MAC

CHECKED BY: MAC

JOB NO.: 2077-16

SEAL

SHEET NO.

A-3.0

LUMIN	LUMINAIRE SCHEDULE										
Symbol	Label	Qty	Catalog Number	Description	Lamp	Lumens	LLF	Watts			
	S	4	US ARCHITECTURAI RZR-IV-FT-80PLED1050mA-NW- 208- RAL-7004-T MOUNTED 25' ABOVE FINISHED GROUND ON CONCRETE POLE	LED POLE MOUNTED LUMINAIRE PAINTED GREY. PROVIDE FOR 2- 3/8" OD TENON MOUNT	EIGHTY WHITE LIGHT EMITTING DIODES (LEDS), VERTICAL BASE- -UP POSITION.	Absolute	0.90	266.7			

STATISTICS					
Description	Symbol	Avg	Max	Min	Max/Min
PARKING AREA (Z=0')	+	2.9 fc	5.2 fc	1.2 fc	4.3:1

SURFACE SCHEDULE							
Reflectances							
Name	Front	Back					
BUIULDING	30%	30%					
DUMPSTER	0%	0%					

LUMINAIRE LOCATIONS											
Location									Aim		
No.	Label	X	Υ	Z	MH	Orientation	Tilt	Χ	Υ	Z	
1	S	-377.2	262.4	25.0	25.0	-90.0	0.0	-378.8	262.4	0.0	
2	S	-366.1	189.4	25.0	25.0	-90.0	0.0	-367.7	189.4	0.0	
3	S	-366.3	119.3	25.0	25.0	-90.0	0.0	-368.0	119.3	0.0	
4	S	-366.2	49.3	25.0	25.0	-90.0	0.0	-367.9	49.3	0.0	

NOTES

1. CALCULATIONS HAVE BEEN PERFORMED ACCORDING TO IES STANDARDS AND PRACTICE. SOME DIFFERENCES BETWEEN MEASURED VALUES AND CALCULATED RESULTS MAY OCCUR DUE TO TOLERANCES IN CALCULATION METHODS, TESTING PROCEDURES, COMPONENT PERFORMANCES, MEASURED CONDITIONS SUCH AS TECHNICAL AND FIELD VOLTAGES AND TEMPERATURE VARIATIONS. INPUT DATA SUCH AS ROOM DIMENSIONS, REFLECTANCES, FURNITURE, LIGHT LOSS FACTOR, FURNITURE, ARCHITECTURAL ELEMENTS AND FOLIAGE SIGNIFICANTLY AFFECT THE LIGHTING CALCULATIONS. IF THE REAL ENVIRONMENT DO NOT MATCH INPUT DATA DIFFERENCES WILL OCCUR BETWEEN MEASURED AND CALCULATED VALUES.


2. CONCRETE POLES ARE TO BE 34' OVERALL LENGTH AND 25' ABOVE GROUND OR AS INDICATED BY BORING TEST RESULTS - SUPPLIED BY OTHERS.


3. WIND LOAD CALCULATIONS, TO MEET SOUTH FLORIDA WIND LOAD REQUIREMENTS, MUST BE PREPARED AND SUBMITTED AS PART OF THE SUBMITTAL PROCESS. SAID CALCULATIONS MUST BE SIGNED AND SEALED BY FLORIDA REGISTERED ENGINEER.

4. POINT-BY-POINT CALCULATIONS PROGRAM USED - VISUAL SERIAL # 5101 5260 4589 0193, VERSION 2.06.0211





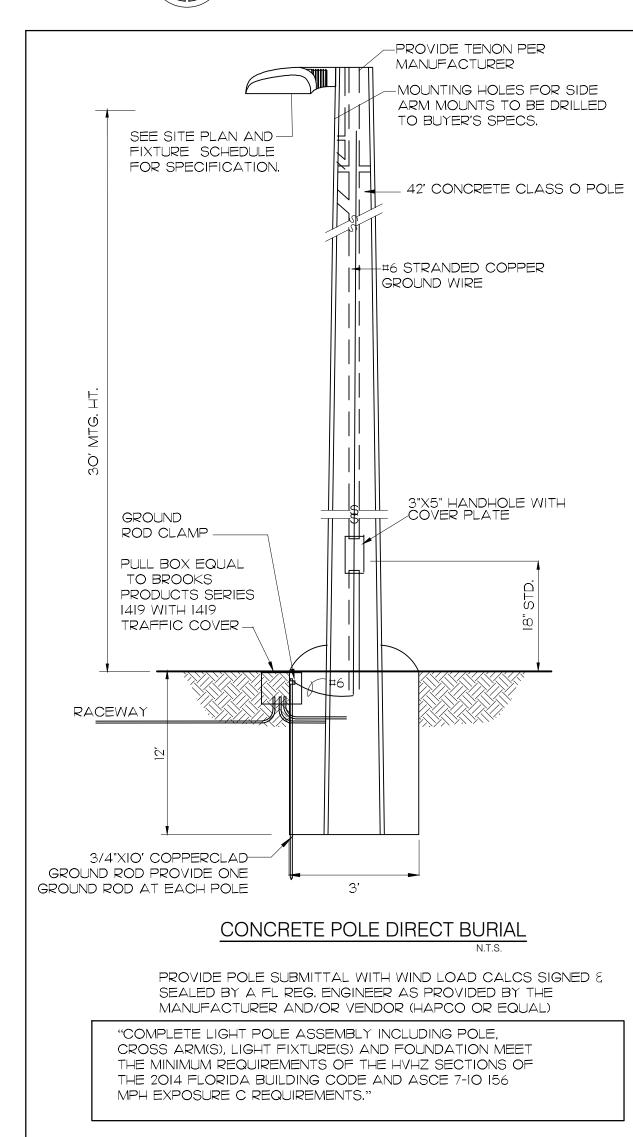

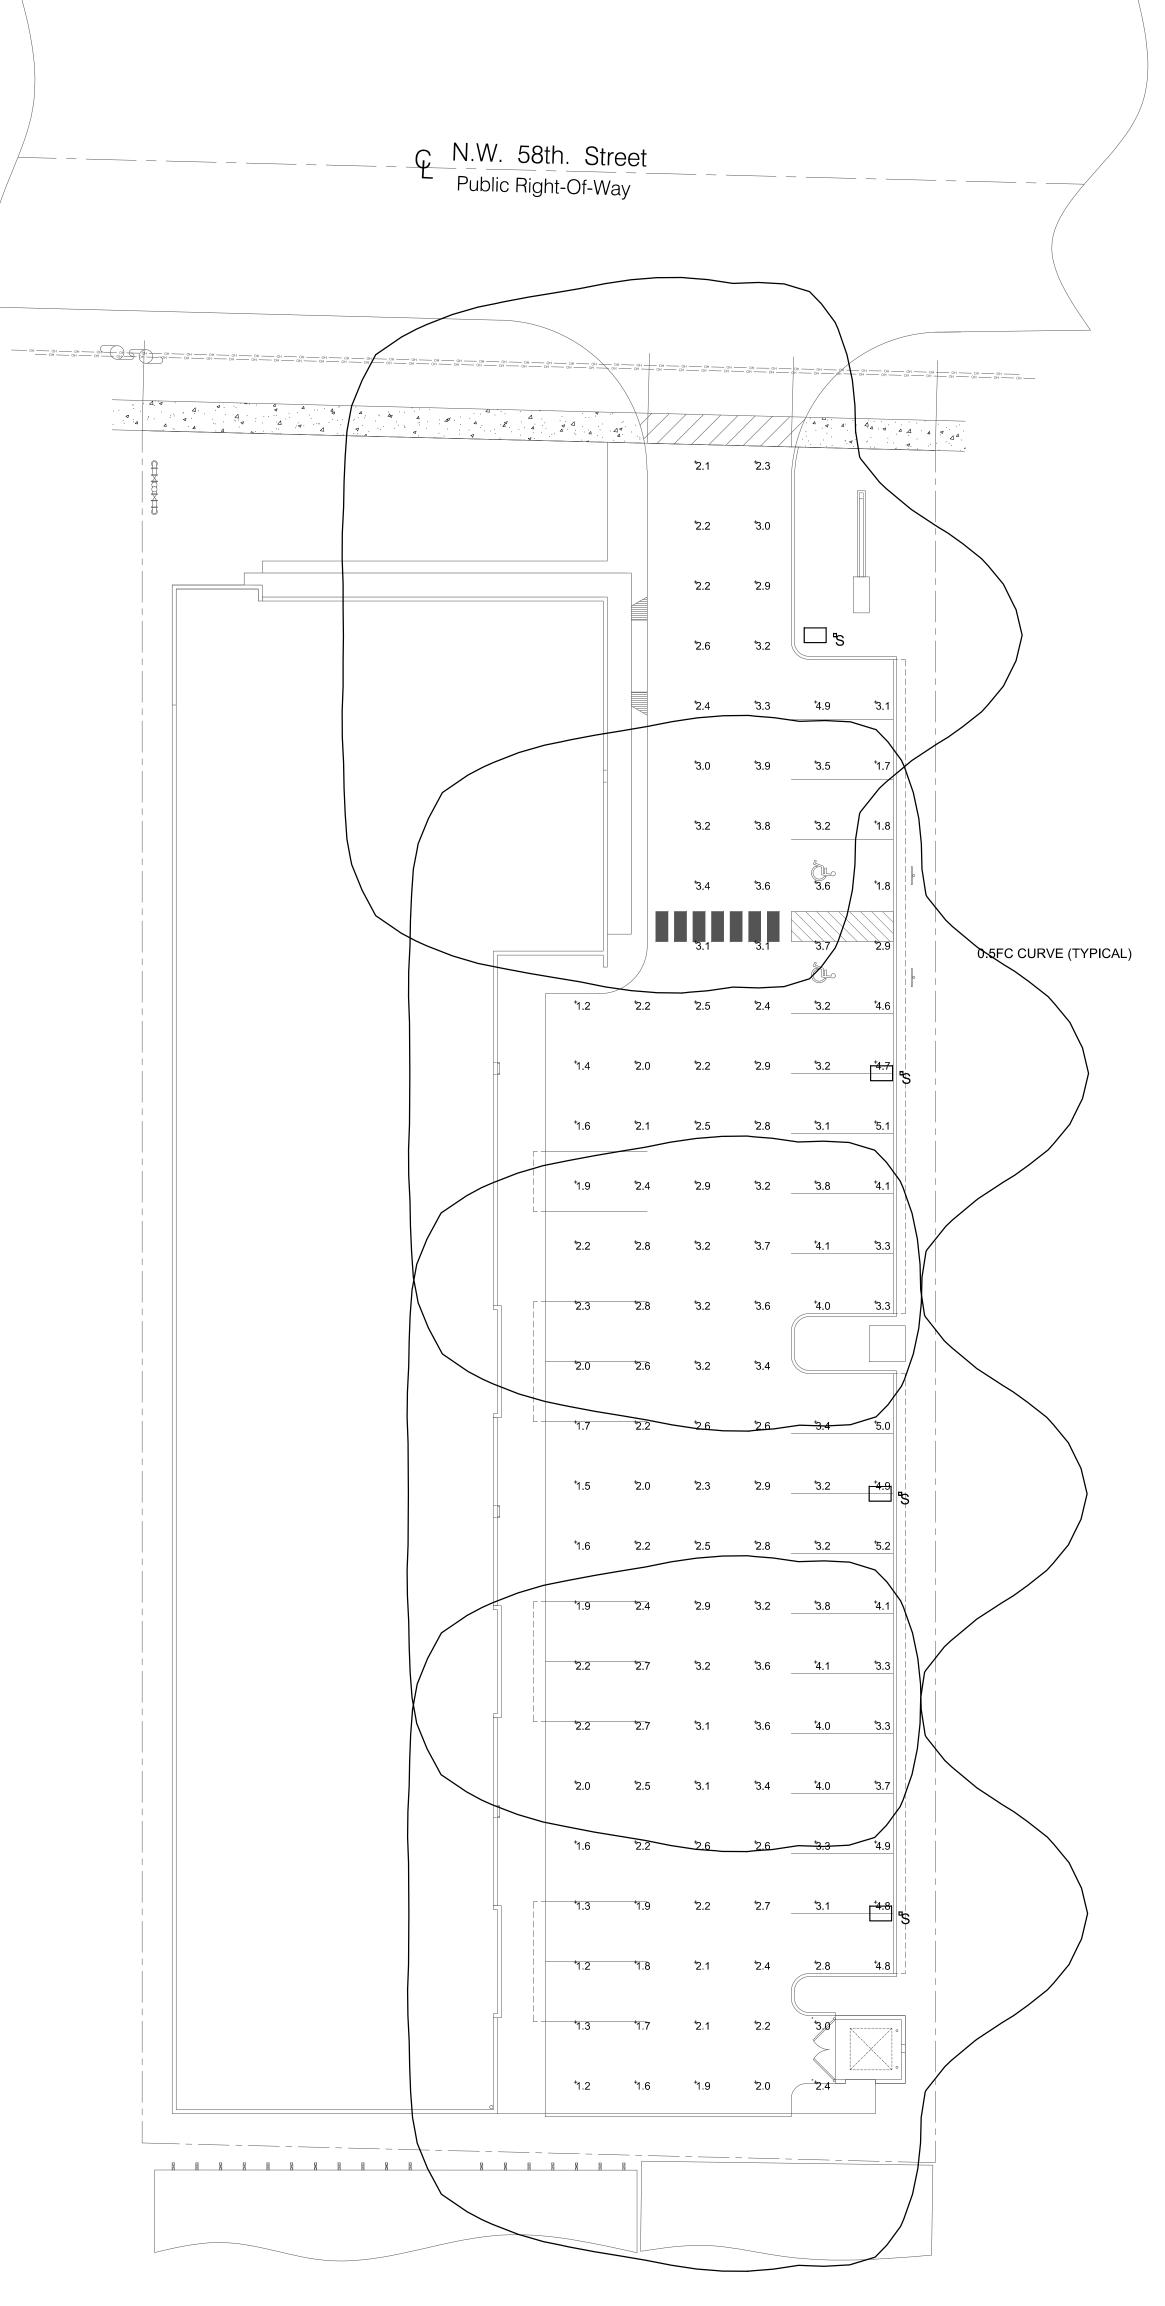



REVISIONS:

8-15-16
ASPR COMMENTS
NEW SHEET

:A LLC t, Doral, FL 33166

DM De Leo N 8470 NW 58

CABRERA RAMOS

Architects, Inc.

9851 NW 58 STREET. #107
DORAL, FLORIDA 33178
T:305.593.0750 F:305.593.8862
AA C001621

MIGUEL A. CABRERA JR., R.A. State Reg. No. AR13118

ROSA E. RAMOS-BOTTA, R.A. State Reg. No. AR15209

© 2016 CABRERA RAMOS ARCHITECTS, INC.
The Design and Drawings for this Project
are the property of the Architect and are
protected under the Copyright Protection Act.

DATE: 04-11-2016

DRAWN: DRC

CHECKED BY: MAC

JOB NO.: 2077-16

SEAL


SHEET NO.

E-1.0

PI	ANTING SPE	CS TABLE				\wedge			\wedge	
SYMI	BOL USED I PLAN	D				HEIGHT @PLANTING	CALIPER	CLEAR TRUNK	QUANTITY	
	1BOL	SCIENTIFIC COMMON						>		}
TR	EES					(> >		}	
QTY.	\\\\\\\\\\\\\\\\\\\\\\\\\\\\\\\\\\\\\	COCCOLOBA DIVERSIFOLIA	PIGEONPLUM	×		14'-0"	2 1/2"	4'	4	
QTY. CS		CASSIA SURATTENSIS	GLAUCOUS CASSIA	X		12'-0"	2 1/2"	N.R.	12	
QTY. VM	Emily my	VEITCHIA MONTGOMERYANA	MONTGOMERY PALM		×	10'-0"			4	
							>		}	
	松							STREET TREES TOTAL PALMS TREES TOTAL TREES	4 (2)	
SH	部協 IRUBS AND GI	ROUND COVER /	2					TOTAL PALMS TREES TOTAL TREES	4 (2)	
SH-QTY.	部隊 IRUBS AND GI	ROUND COVER /2 CONOCARPUS ERECTUS (SHRUBS)	SILVER BUTTONWOOD	×		36"		TOTAL PALMS TREES TOTAL TREES	4 (2)	
QTY.	(CONOCARPUS ERECTUS	SILVER	×				TOTAL PALMS TREES TOTAL TREES	4 (2) 12 18	
QTY. CE	(CONOCARPUS ERECTUS (SHRUBS) CHRYSOBALANUS	SILVER BUTTONWOOD			36"	N/A	TOTAL PALMS TREES TOTAL TREES N/A	4 (2) 12 18	
QTY. CE QTY. CI	(CONOCARPUS ERECTUS (SHRUBS) CHRYSOBALANUS ICACO (SHRUBS) MURRAYA PANICULATA	SILVER BUTTONWOOD COCOPLUM ORANGE	X		24"	N/A N/A	TOTAL PALMS TREES TOTAL TREES N/A N/A N/A	4 (2) 12 18 65 4 (2) 91	

Zoning District: I- INDUSTRIAL Net Lot Area: 0.86 acres 37,722 squa	re teet	
OPEN SPACE	REQUIRED	PROVIDED
A. Square feet of open space required by Chapter 33, as indicated on site plan: Net lot area = 37,722 square feet x15 % = 5,658 square feet	5,658	(8,980)
B. Square feet of parking lot open space required by Chapter 18A, as indicated on site plan: The number of parking spaces 27 10 square feet per parking space =	270 /	(270)
C. Total square feet of landscaped open space required by Chapter $33 = A + B =$	5,948	9,250
LAWN AREA CALCULATION		
A. Total square feet of landscaped open space required by Chapter 33 =	5,948	
B. Maximum lawn area (St. Augustine sod) permitted = 20 % x 5,948 square feet =	= 1,189 max	c. <u>1,100</u>
TREES	\sim 2	
A. The number of trees required per net lot acre	(15)	
less the existing number of trees that meet minimum requirements (minu	us)	
= 15 trees x net lot acreage = 12.9	13	
B. 30% palm trees allowed (two palms = one tree) Palms provided =	4 tree equiv. (8 palms max.)	2 tree equiv. (4 palms)
C. Percentage of native trees required = the number of trees provided x 30% =	(6 min.) /	16
D. Street trees (max. average spacing of 35' o.c.): 132.22' linear feet along street ÷ 35 =	4	4
Palms as street trees (max. average spacing 25' o.c.): N/A linear feet along street ÷ 25	= <u>N/A</u>	N/A
E. Street trees located directly beneath power lines (maximum average spacing of 25' o.c.):		
N/A linear feet along street $\div 25 =$	N/A	N/A
F. Total number of trees provide d =	17	18
SHRUBS		/
A. The total number of trees required $x = 10$ = the number of shrubs required	130	£ 156 \ \ \ \ \ \ \ \ \ \ \ \ \ \ \ \ \ \ \
B. The number of shrubs required x 30% = the number of native shrubs required	39	(156)

BUFFER YARD REQUIREMENTS AS PER CHAPER 7 SECTION 6 (h): NO BUFFER YARD REQUIRED BECAUSE ALL LAND USES ARE SAME (INDUSTRIAL LESS THAN .65 ISR)

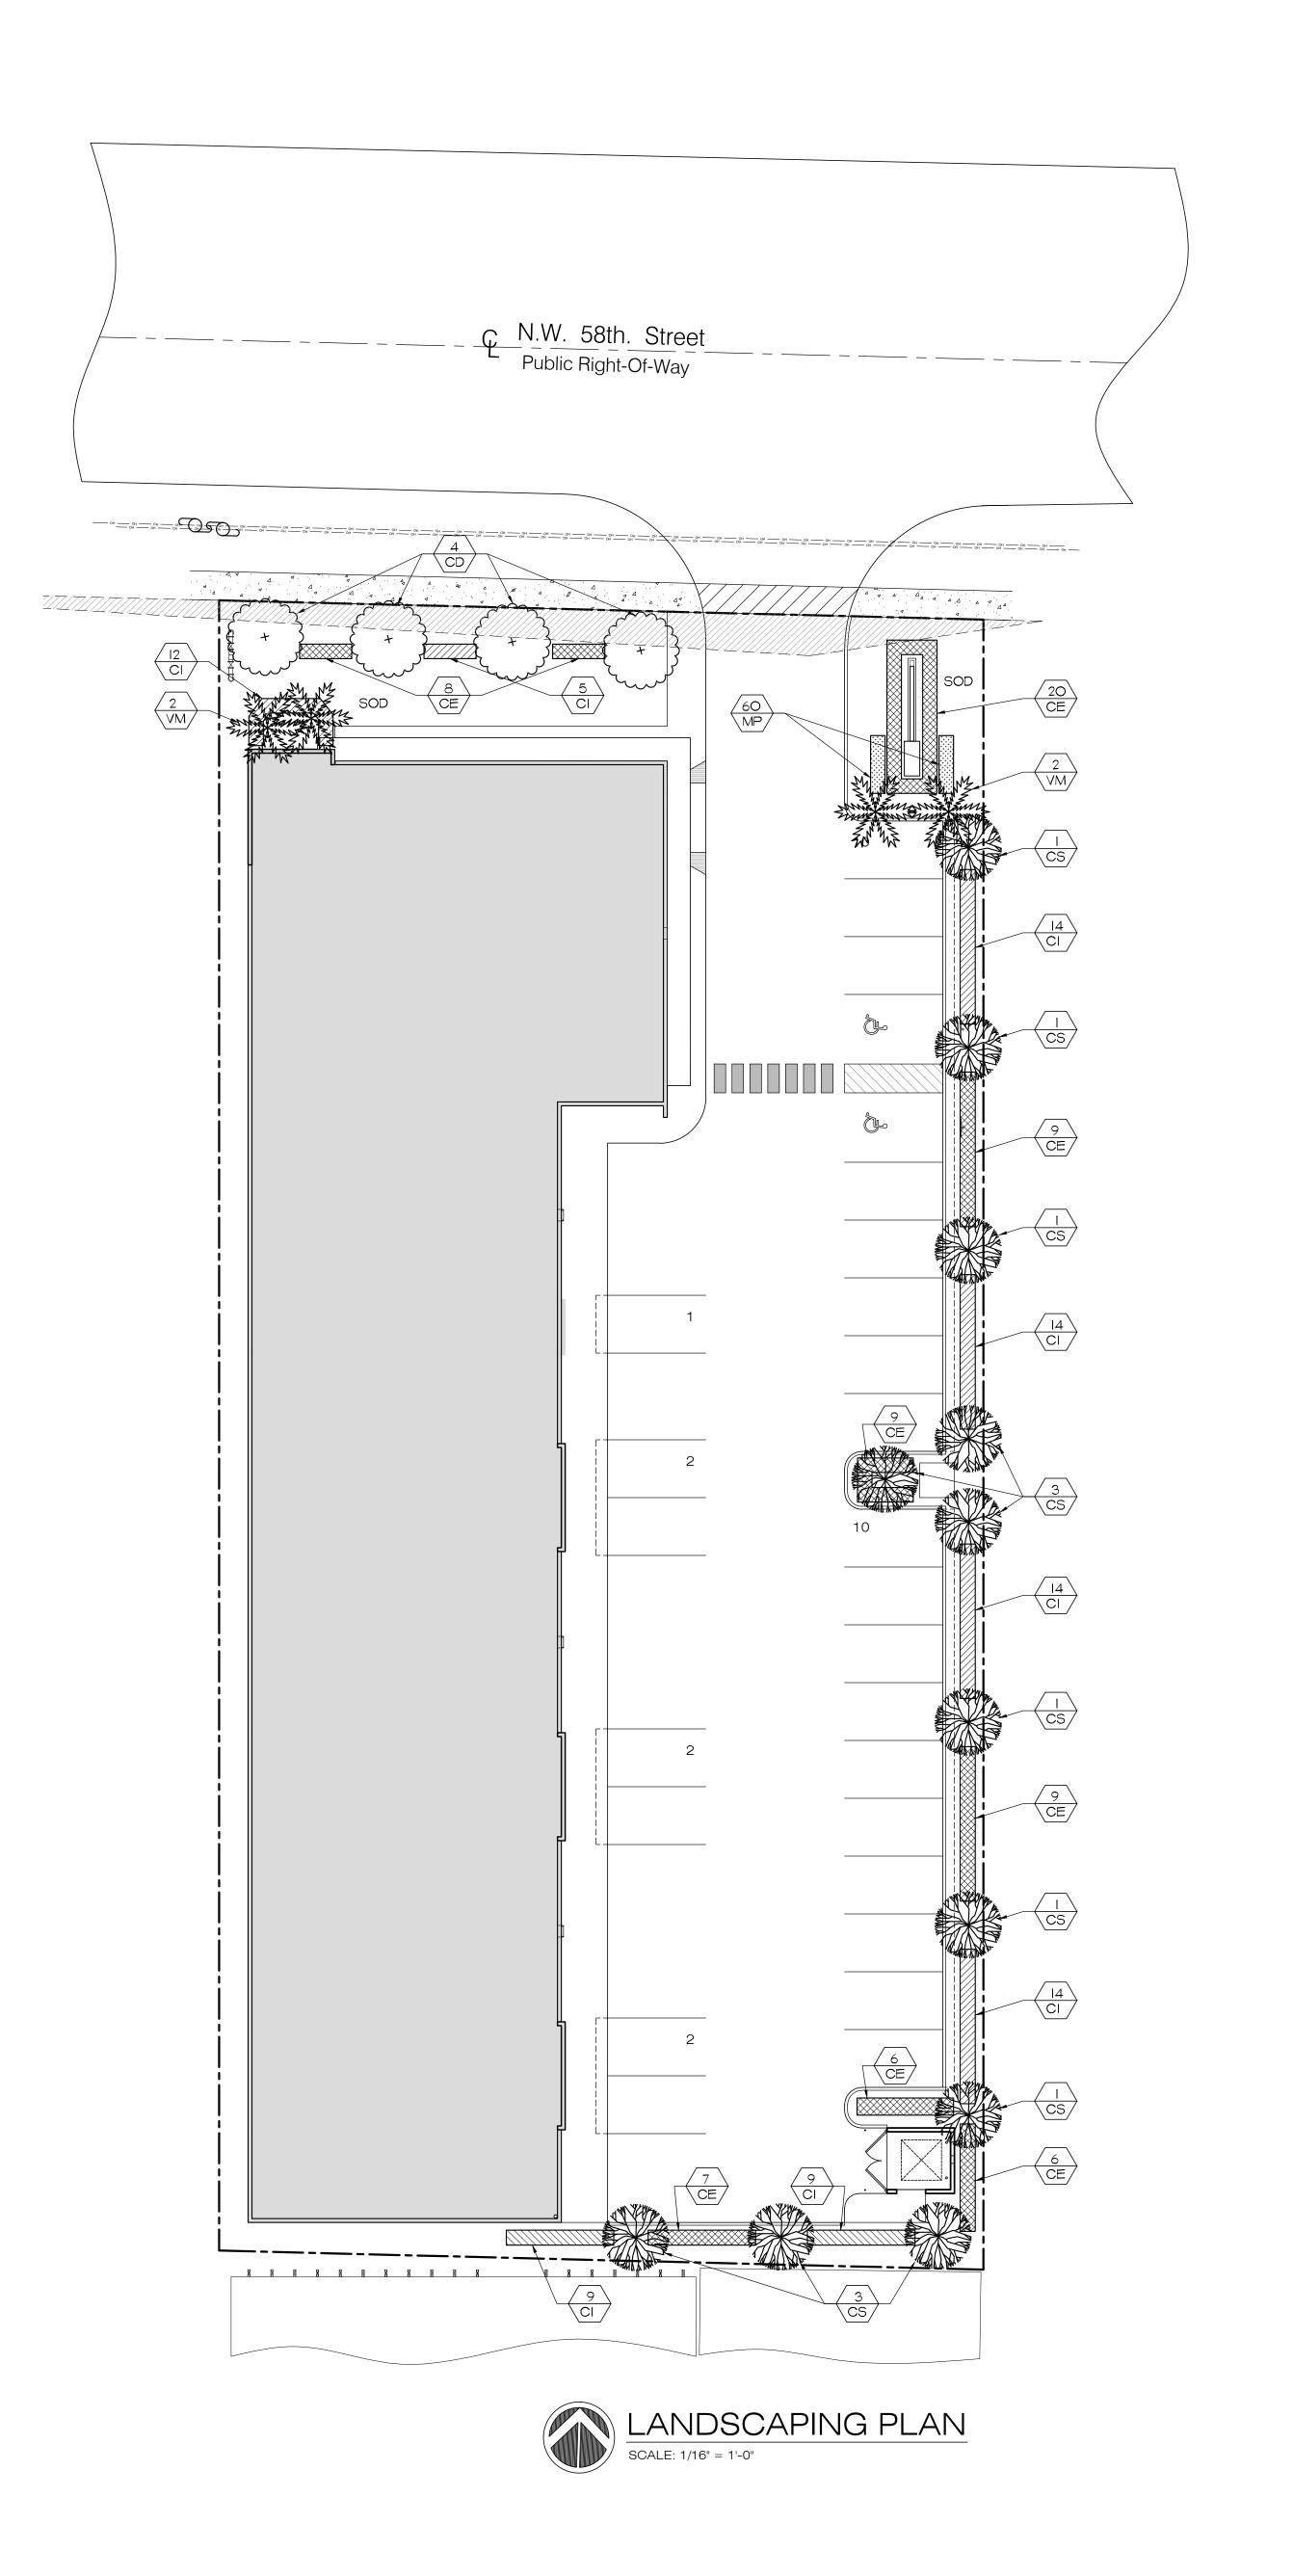

REVISIONS:

8-15-16 ASPR COMMENTS 9-22-16 ASPR COMMENTS

CABRERA RAMOS

ARCHITECTS,INC. 9851 NW 58 STREET. #107 DORAL, FLORIDA 33178 T:305.593.0750 F:305.593.8862 AA C001621

> MIGUEL A. CABRERA JR., R.A. State Reg. No. AR13118 ROSA E. RAMOS-BOTTA, R.A. State Reg. No. AR15209

© 2016 CABRERA RAMOS ARCHITECTS, INC.

The Design and Drawings for this Project

are the property of the Architect and are

protected under the Copyright Protection Act.

CHECKED BY: MAC JOB NO.: 2077-16

SEAL

SHEET NO.

L-1.0